SPECIAL PERMIT 107 School Street

107 School Street, Somerville, MA 02143









Š .	F		
1 −40	1	REVISI	
	No.	Descripto	n.
	\vdash		
	An 875 Te	ndersonPo 5 Main Street Cam al. 617.354.2501 F	rterDes
	Project	107 SCHC	
	Address	107 SCHOOL SOMERVILLE	
	Title	COVER :	SHEET
	Drawing	lowed By: ANDERSON	N PORTER DES
	Proj. #	1817	Drawing No.
1	Date:	08/02/2018	00
Annual Property lies	Scale	AS NOTED	G0.
	Drawn B	⊭ GGO	


LIST OF SYMBOLS	ABBREVIATIONS	SITE LOCATION
DISTING PARTITION OR PARTITION W/ DOOR = 1 TO BE REMOVED, REFER TO D1 DRAWINGS.	AFF ABOVE FINISHED FOOR CJ CONTROL JOINT CLG CEILING CLR CLEAR	To deposit
EXISTING STRUCTURE OR PARTITION TO REMAIN.	CO CLEAN OUT COL COLUMN CONC CONCRETE	O == ====
NEW STRUCTURE OR PARTITION.	CONT CONTINUOUS DN DOWN EJ EXPANSION JOINT	amends to comp ♥
RIST ROOF FINISH ELEVATION.	EL ELEVATION ELEC ELECTRICAL EQ EQUAL	1 1 1 1 1 1 1 1 1 1 1 1 1 1 1 1 1 1 1
GENERAL DETAIL	EXIST EXISTING FC FURRING CHANNEL FD FLOOR DRAIN	
WALL SECTION	FIN FINSH FL FLOOR GL GLASS	N. C.
INTERIOR ELEVATION	GWB GYPSUM WALLBOARD HT HEIGHT HDWD HARDWOOD	
DOOR IDENTIFICATION SYMBOL	HAAC HEATING YEATHATION AND AR CONDITIONING INSUL INSULATION MAX MAXIMUM	DRAWING LIST
(1) WINDOW IDENTIFICATION SYMBOL (CONC. 1 1) FLOOR FINISH SYMBOL	MFR MANUFACTURER MIN MINIMUM MO MASONRY OPENING	ABCHTECTURAL GO.1 COVER SHEET CO.1 EXISTING SITE PLAN
(CONC 1) FLOOR FINISH SYMBOL WALL TYPE TAG	MTL METAL NIC NOT IN CONTRACT NTS NOT TO SCALE	A0.1 PROPOSED SITE PLAN 21.1 ZONING CALCULATIONS AX1.1 EXISTING FLOOR PLANS
P-1 FINISH TAG	OC ON CENTER PLAM PLASTIC LAMINATE PLYWO PLYWOOD PTO PAINTED	AV.1 EXPINIS FLOUR PLANS AV.1 EXPINIS ELEVATIONS A1.1 PROPOSED FLOOR PLANS A1.2 PROPOSED FLOOR PLANS
101 ROOM TAG	RECOV RECOURED RL ANI LEADER STL STEEL STEL STEEL STEL STEUCTURE/STRUCTURAL	A2.1 PROPOSED ELEVATIONS A2.2 PROPOSED ELEVATIONS
▼ CAT 5/COAX/DATA	TYP TYPICAL UNO UNIESS NOTED OTHERWISE VCT VINIL COMPOSITION TILE	CONTACT
P DUPLEX OUTLET	WO WOOD W/ WITH WNDW WINDOW	ARCHITECT Anderson Porter Design 875 Main Street
GROUND FAULT OUTLET	AADDA MINDOM	Cambridge, MA 02139
		Dan Anderson 617-354-2501

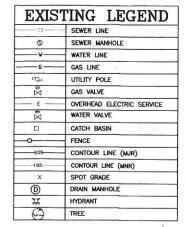

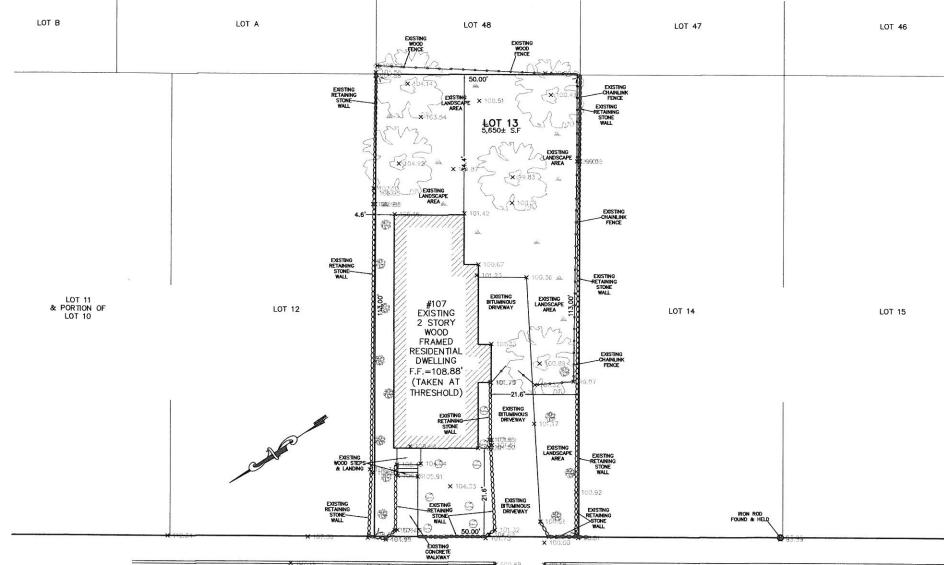


NOTES:

- 1. INFORMATION SHOWN ON THIS PLAN IS THE RESULT OF A FIELD SURVEY PERFORMED BY PETER NOLAN & ASSOCIATES LLC AS OF 6/6/2018.
- 2. DEED REFERENCE BOOK 12072 PAGE 218, PLAN REFERENCE BOOK 7 PLAN 40 MIDDLESEX SOUTH DISTRICT REGISTRY OF DEEDS.
- 3. THIS PLAN IS NOT INTENDED TO BE RECORDED.
- 4. I CERTIFY THAT THE DWELLING SHOWN IS NOT LOCATED WITHIN A SPECIAL FLOOD HAZARD ZONE. IT IS LOCATED IN ZONE X, ON FLOOD HAZARD BOUNDARY MAP NUMBER 25017C0438E, PANEL NUMBER 0438E, COMMUNITY NUMBER: 250214, DATED JUNE 4. 2010.
- 5. THIS PLAN DOES NOT SHOW ANY UNRECORDED OR UNWRITTEN EASEMENTS WHICH MAY EXIST. A REASONABLE AND DILIGENT ATTEMPT HAS BEEN MADE TO OBSERVE ANY APPARENT USES OF THE LAND; HOWEVER THIS NOT CONSTITUTE A GUARANTEE THAN NO SUCH EASEMENTS EXIST.
- 6. FIRST FLOOR ELEVATIONS ARE TAKEN AT THRESHOLD.
- 7. NO RESPONSIBILITY IS TAKEN FOR ZONING TABLE AS PETER NOLAN & ASSOCIATES LLC ARE NOT ZONING EXPERTS. TABLE IS TAKEN FROM TABLE PROVIDED BY LOCAL ZONING ORDINANCE. CLIENT AND/OR ARCHITECT TO VERIFY THE ACCURACY OF ZONING ANALYSIS.
- 8. ZONING DISTRICT = R.A. RESIDENCE A

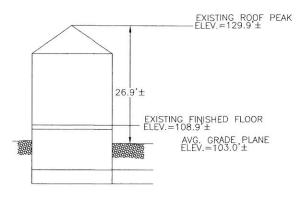


EXISTING PROFILE NOT TO SCALE

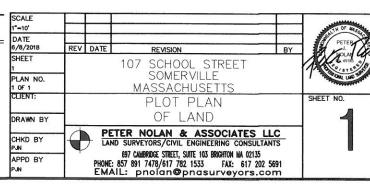

SCHOOL STREET

× 99.09

GRAPHIC SCALE (PUBLIC WAY-VARIABLE WIDTH)

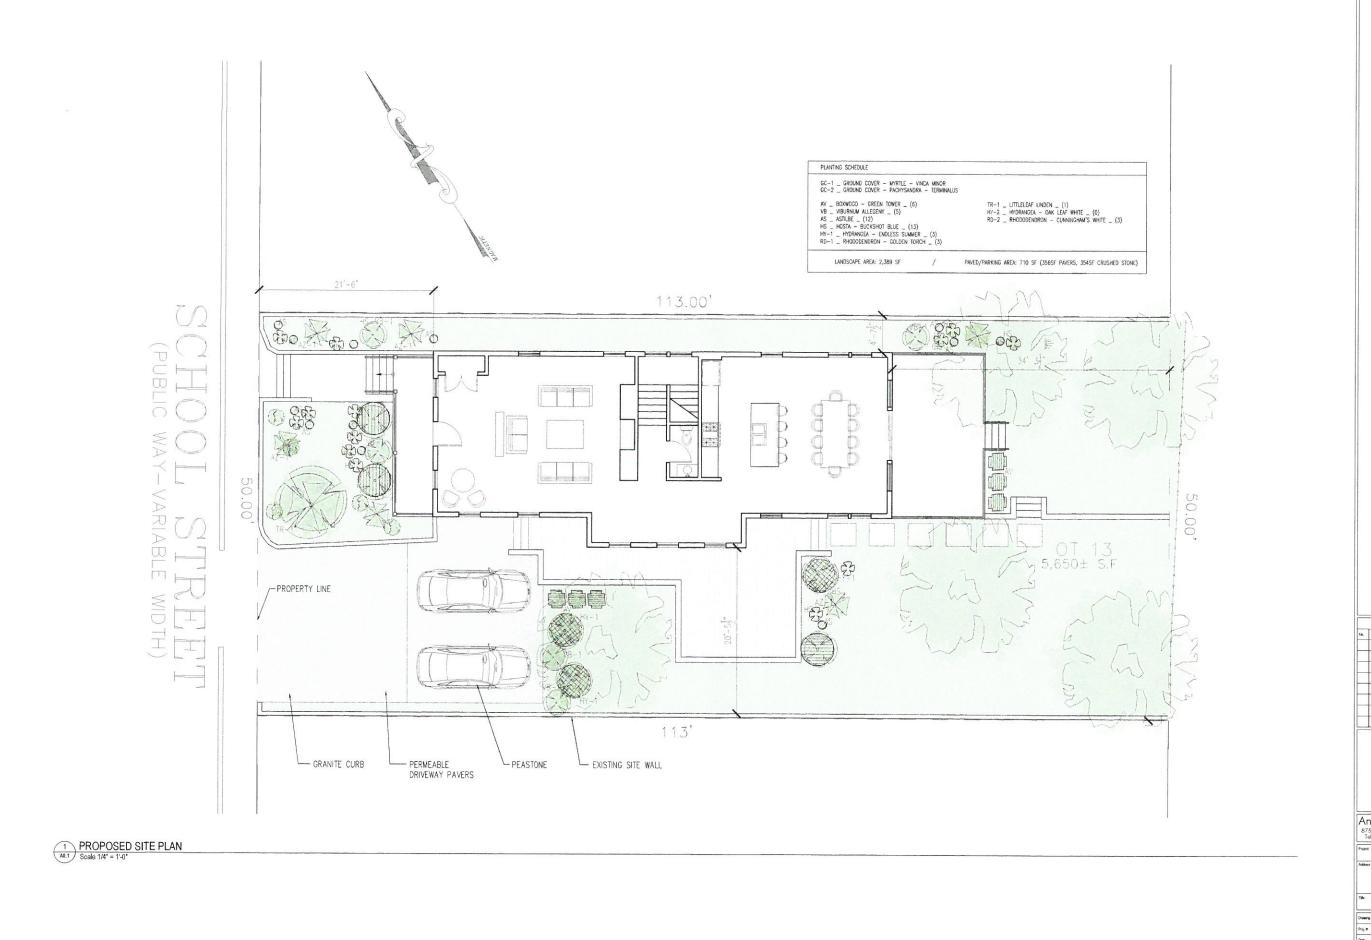

REVISIONS

AndersonPorterDesign 875 Main Street Cambridge, MA 02139 Tel. 617.354.2501 Fax. 617.354.2509

107 SCHOOL ST


107 SCHOOL STREET SOMERVILLE, MA 02143


PROPOSED SITE PLAN


Data	Existing	Proposed	Allowed	Existing or Permitted Nonconformity	New Violation	SZO Section Cited
	Fill in both columns: number plans and other attack	Office Use				
A. Use	Residence RA	Residence RA				
B. # of Dwelling Units*	1 units	2 units				
C. Lot Area	5650 square feet	5650 square feet				
D. Lot Area ÷ # of Dwelling Units	5650 sf per du	2825 sf per du				
E. Gross Floor Area of Footprints of All Buildings	1161 square feet	1468 square feet				
F. Ground Coverage (E. ÷ C.)	20 %	26 %				
G. Landscaped Area (landscaped area ÷ C.)	64 %	47 %				
H. Pervious Area (pervious area ÷ C.)	64 %	60 %				
Net Floor Area** / *** (sum of all usable square feet)	1872 square feet	3242 square feet				
J. Floor Area Ratio (FAR) (I. ÷ C.)	0.33	0.57				
K. Building Height	. 26.9 feet	32.7 feet				
L. Front Yard Setback	21.6 feet	21.6 feet				
M. Rear Yard Setback	34.4 feet	22.9 feet				
 N. Side Yard Setback (left when you face property) 	4.6 feet	4.6 feet				
Side Yard Setback (right when you face property)	21.6 feet	21 feet				
P. Street Frontage	50 feet	50 feet				
Q. # of Parking Spaces	1	2				
R. # of Bicycle Parking Spaces	0	0				
\$. # of Loading Spaces* 8 or more dwelling units - determine	0	0		100000000000000000000000000000000000000	S. 15	






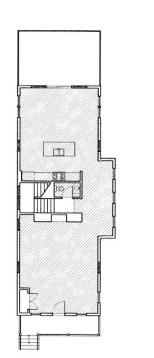

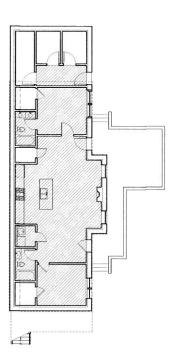

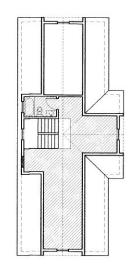

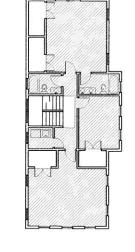

03 SECOND FLOOR PLAN
21.1 Scale 3/32* = 1'-0"

02 Z1.1) FIRST FLOOR PLAN Scale 3/32" = 1'-0*

01 LOWER LEVEL FLOOR PLAN 21.1 Scale 3/32* = 1'-0*

REVISIONS


AndersonPorterDesign 875 Main Street Cambridge, MA 02139 Tel. 617.354.2501 Fax. 617.354.2509 107 SCHOOL ST


107 SCHOOL STREET SOMERVILLE, MA 02143


ZONING COMPLIANCE

Driming Issued By ANDERSON PORTER DESIGN | Prig # 1817 | Drink 08/02/2018 | Soile AS NOTED | Drink GGO

04 THIRD FLOOR PLAN
Scale 3/32* = 1'-0*

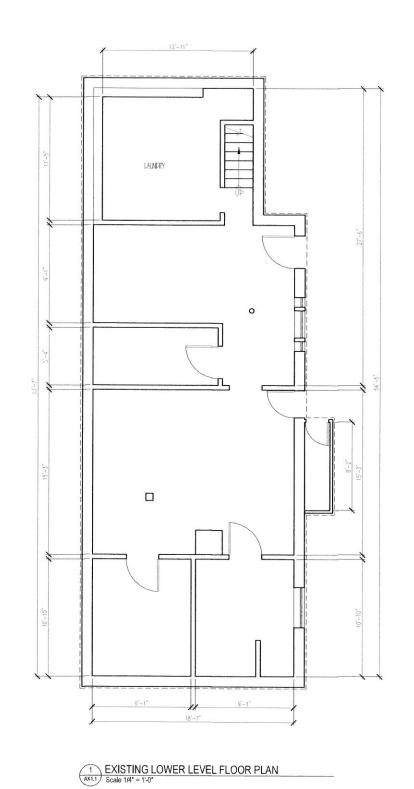

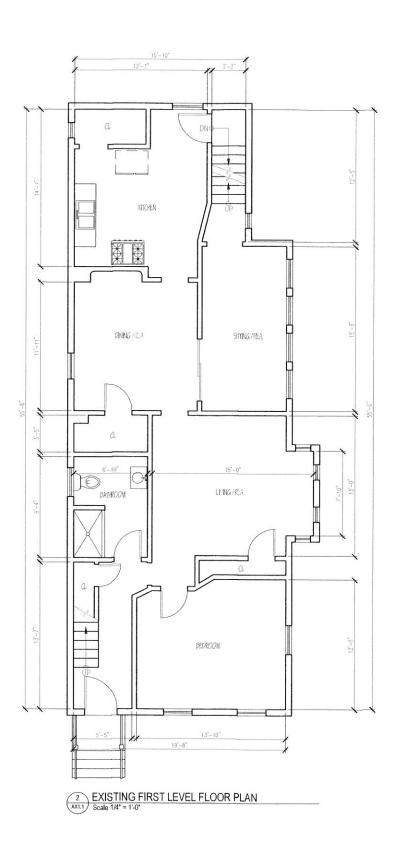

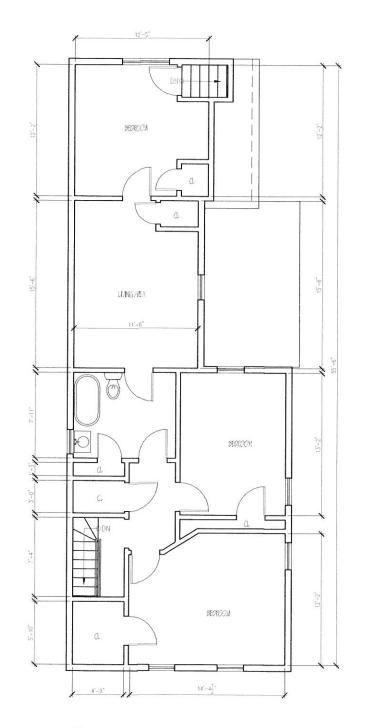

3 EXISTING SECOND LEVEL FLOOR PLAN
Scale 1/4" = 1'-0"

R E V I S LO N S

Hu. Creurablen Dub


AndersonPorterDesign 875 Main Street Cambridge, MA 02139 Tel. 617.354.2501 Fax. 617.354.2509


Project 107 SCHOOL ST

107 SCHOOL STREET SOMERVILLE, MA 02143

EXISTING PLANS

| Dissequenced by ANDERSON PORTER DESIGN | Pring # 1817 | Dissequence |

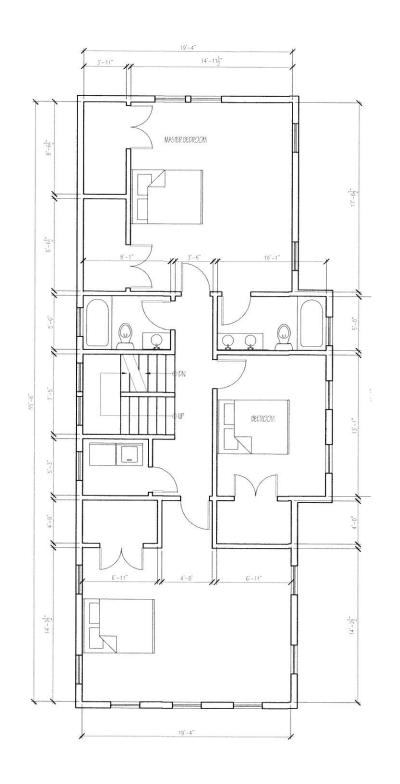

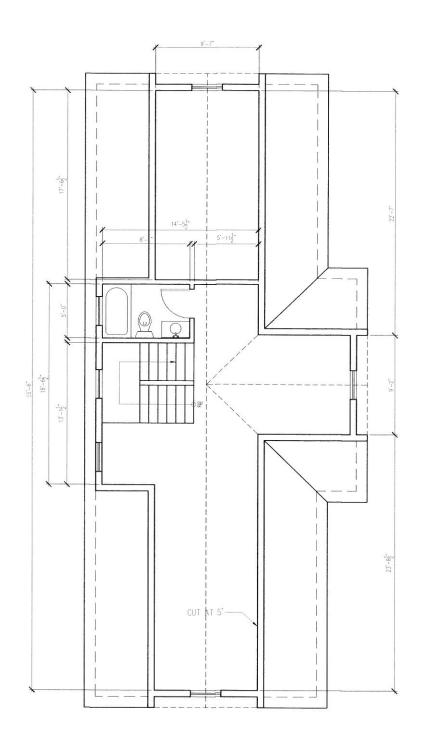

AndersonPorterDesign 875 Main Street Combridge, MA 02139 Tel. 617.354.2501 Fax. 617.354.2509

REVISIONS

Project 107 SCHOOL ST

107 SCHOOL STREET SOMERVILLE, MA 02143

PROPOSED PLANS

| Dissentance Sp. ANDERSON PORTER DESIGN | Phys. # 1817 | Dissent Object | Dissentance | Dissentance

PROPOSED SECOND LEVEL FLOOR PLAN
Scale 1/4" = 1'-0"

PROPOSED THIRD LEVEL FLOOR PLAN
Scale 1/4" = 1'-0"



